



Proposed Ground Floor Plan


Fire Evacuation Key

	Existing wall to achieve min 30 minute fire rating (suitability of wall to be confirmed on site by Pure Gym Main Contractor	Unit Occupancy: In line with the LL's existing Fire 1 total floor area of 1843m2 as perm occupancy would be 351 occupa
	Existing wall to achieve min 60 minute fire rating (suitability of wall to be confirmed on site by Pure Gym Main Contractor	Escape Route Requirements: In line with the LL's existing Fire S
	New wall to achieve min of 30min fire rating	an automated fire detection has distances, horizontal and vertica Strategy the unit has been desig
	New wall to achieve min of 60min fire rating	This results in the following limito Single direction horizontal travel Alternative direction horizontal to Door & corridor widths factor 5.3
	Protected areas: walls, floors, ceilings and doors to achieve 30minute fire resistant construction.	Stair widths factor - 5.95mm/per Horizontal Means of Escape Exit A Clear Opening Width = 1500
	Protected areas: walls, floors, ceilings and doors to achieve 60 minute fire resistant construction.	Exit B Clear Opening Width = 1230 Exit C Clear Opening Width = 1500 This results in a total horizontal e
	Fire Escape Route	<u>Vertical Means of Escape</u> Staircase 1 Clear Width = 1800mm Staircase 2 Clear Width = 1300mm
1050 min	Minimum Clear Widths	Staircase 3 Clear Width = 1280mm Taking into account that only sto vertical escape capacity is limite
0	Exit No.	The final exit width from each sto to vertical circulation.
	Protected Escape Route	Under the LL Fire Evacuation Stro other unit will not be required to discounted as a consideration.

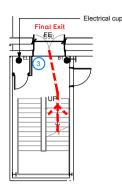

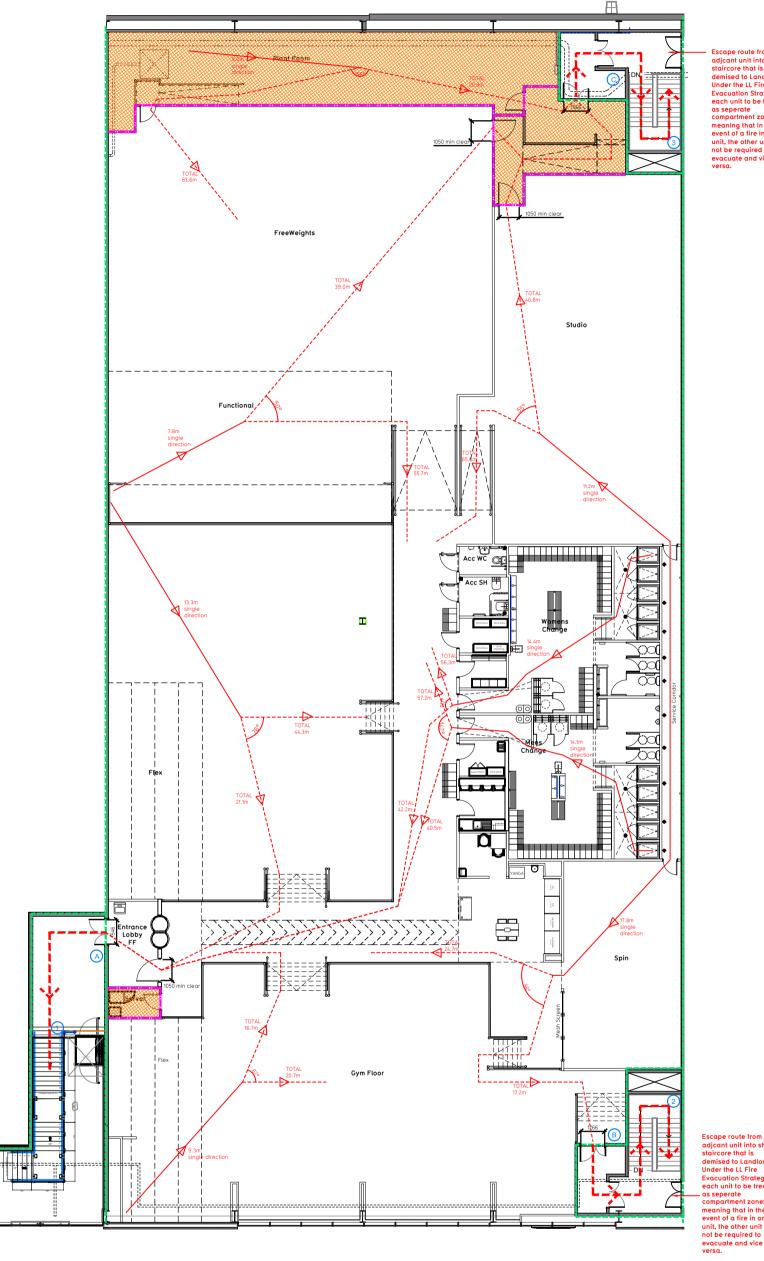



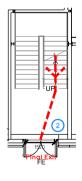

<u>Occupancy:</u> e with the LL's existing Fire Strategy the forecasted Design Occupancy for the unit is <mark>460 persons</mark> based upon a Floor Space Factor of 4m2/person and floor area of 1843m2 as permitted under BS9999. However, based upon PG's own empirical data for a gym of this size and nature, the forecasted peak bancy would be <mark>351 occupants</mark> .
be Route Requirements: a with the LL's existing Fire Strategy PG escape route requirements have been calculated in accordance with BS9999. BS9999 recognises the impact that utomated fire detection has on the evacuation of the building as it permits a 15% enhancement on the minimum requirements. Consequently the travel nces, horizontal and vertical escape requirements have been calculated in accordance with the above enhancement. In line with the LL's existing Fire egy the unit has been designated as a having a Risk Profile of B3 relating to Occupancy Characteristics and Fire Growth Rate.
esults in the following limitations: e direction horizontal travel distance – 18.4m aative direction horizontal travel distance – 46m & corridor widths factor 5.3mm/person widths factor – 5.95mm/persons

o<mark>ntal Means of Escape</mark> Clear Opening Width = <mark>1500mm</mark> (allows 283 persons to escape based upon a door width of 5.3mm per person) Clear Opening Width = <mark>1230mm</mark> (allows 232 persons to escape based upon a door width of 5.3mm per person) Clear Opening Width = <mark>1500mm</mark> (allows 283 persons to escape based upon a door width of 5.3mm per person) (largest opening to be discounted) sults in a total horizontal escape capacity following discounting of Exit C (Less Largest Opening Width of 1500mm) = 515 persons

<u>al Means of Escape</u> ase 1 Clear Width = 1800mm (Allows 302 persons to escape) (largest opening to be discounted) ase 2 Clear Width = 1300mm (Allows 218 persons to escape) ase 3 Clear Width = 1280mm (Allows 215 persons to escape)

into account that only staircase 2 and 3 have lobby protection, Staircase 1 is to be discounted from the vertical escape capacity. Consequently the total al escape capacity is limited 433 persons.

al exit width from each stair is to be the same width as the stair that it serves therefore meaning that the staircase width is the limiting factor with regards

the LL Fire Evacuation Strategy each unit is to be treated as a separate compartment zones. Thus meaning that in the event of a fire in one unit, the unit will not be required to evacuate and vice versa. Consequently, the fact that Staircase 2 and 3 are shared with the adjacent unit/tenant can be Inted as a consideration.

------Limiting Factor on Unit Occupancy

Taking into account the forecasted Design Occupancy, Horizontal and Vertical Means of Escape the limiting factor on the units occupancy number the providing adequate means of escape in the event of a fire, is the Vertical Means of Escape. Consequently, the overall unit occupancy number 433 persons. Taking into account PG's own empirical data, this limitation of 433 persons is more than sufficient for the 351 occupants forecasted for size and nature. This is therefore thought to meet the requirements set out within BS9999 and comply with Building Regulations. Evacuation of Disabled Occupants Disabled refuge points are to be located within all three protected cores. These will measure 1400mm x 900mm and will be located so as to not obs routes and clear exit widths. A two way Emergency Voice Communication (EVC) system will be installed to comply with BS 5839-9. A master panel si located in close proximity to the units main fire alarm panel.

Fire Alarm Fire Alarm designed and installed to BS 5839. Smoke & heat detection / emergency lighting by specialist. Please refer to M&E engineer's drawings specifications.

Escape Lighting Emergency escape lighted designed and installed in accordance with BS 5266: Part 1. Please refer to M&E Engineer's drawings for final layout and specification. Escape Signage and emergency lighting is CDP under the M&E specification. Details of contractors proposals to be provided to Build Approved Inspector and Fire Officer within the Contractors Proposals Package, Clause 1.4

NOTE:

- Proposals must comply with all acoustic, fire & building regulation requirements
- No dimensions are to be scaled from this drawing. The contractor is responsible for checking all dimensions on site

cape route from
jcant unit into shared
lircore that is
mised to Landlord.
der the LL Fire
acuation Strategy
ch unit to be treated
seperate
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ent of a fire in one
it, the other unit will
t be required to

nbers in relation ber is limited to d for a gym of this										
	C02 11.04.22 Drawing updated to reflect General Arrangement Plan Rev C02							IR/PG		
obstruct escape el should be	C01	23.03.22 Additional door in Freeweights for plant room escape.					HI/IR			
		Date	Description						Drawn/ 0	Checked
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and Building Control	HI	n / CHECKED / IR NG PURPOS	08.03.	22	SCALE 1:200 @ A	.1	JOB No 1132	DRAWING No 002-FEP		Rev
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